
BUILDING TYPE I - RIGHT SIDE ELEVATION SCALE: 3/32"=1'-0"

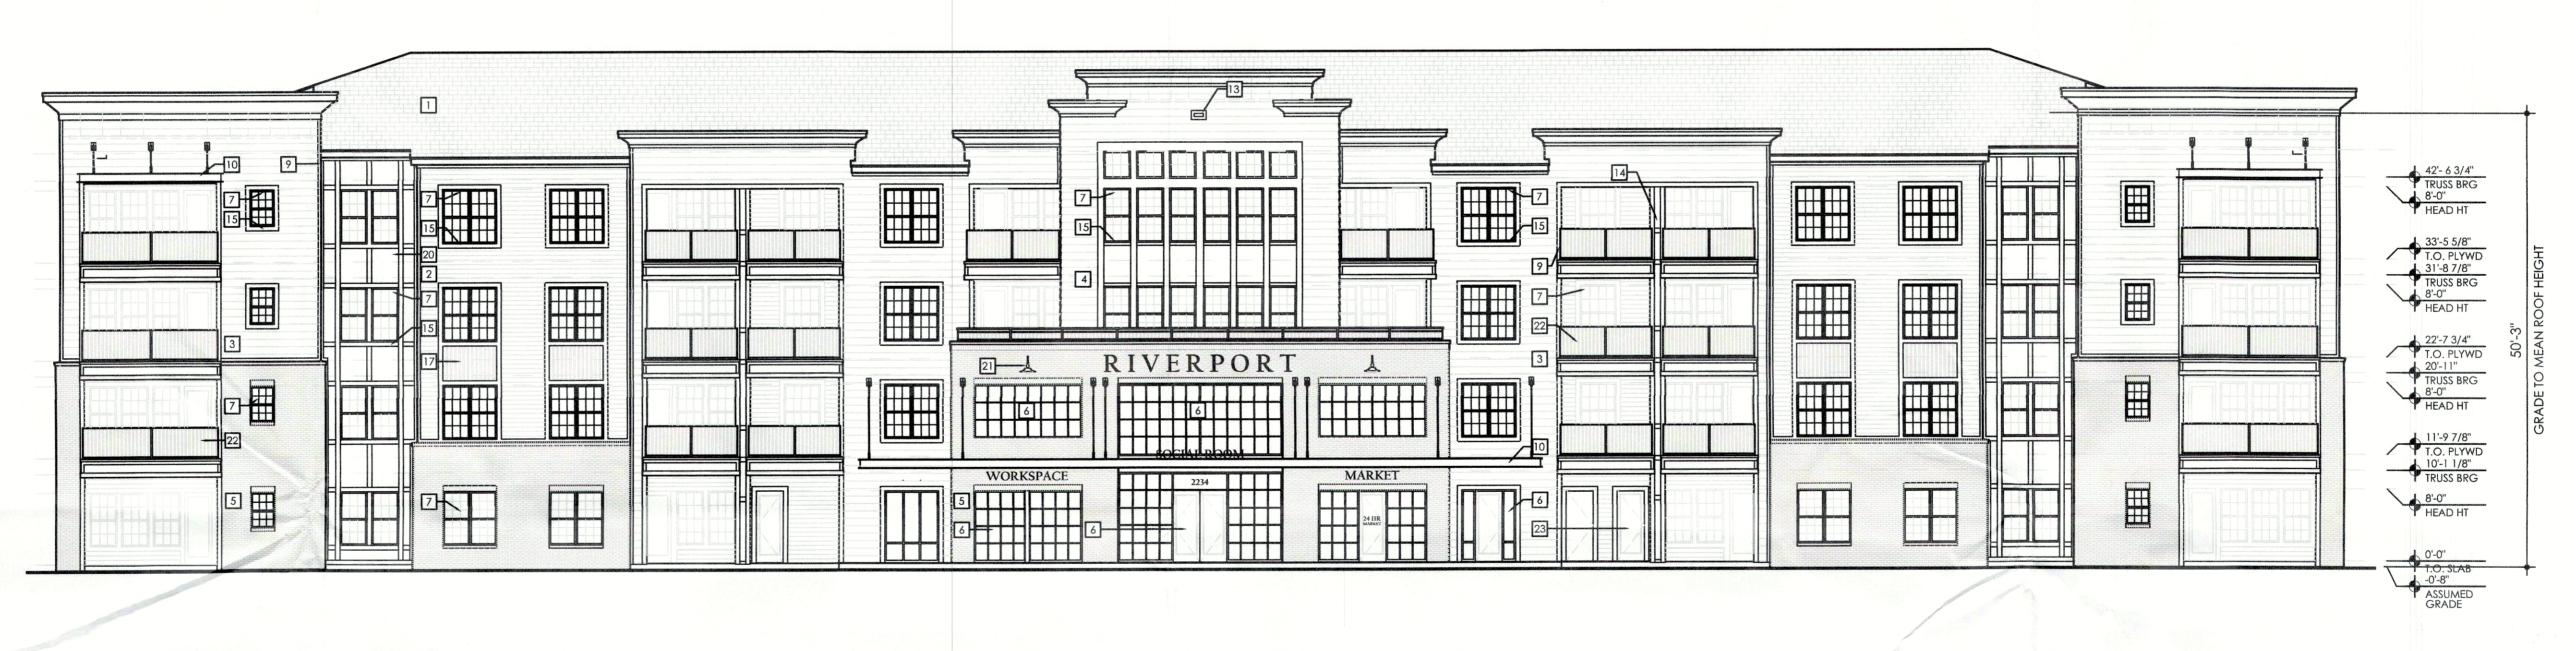

BUILDING TYPE I - FRONT ELEVATION

SCALE: 3/32"=1"-0"

HECEIVED SEP 13 2019 PLANNING & DESIGN SERVICES

### **ELEVATION KEYED NOTES**

- ARCHITECTURAL GRADE ASPHALT SHINGLES ON #30 FELT OVER ROOF SHEATHING ON
- PRE-ENGINEERED WOOD TRUSSES ANCHORED @

FIBER CEMENT LAP SIDING WITH 6" REVEAL OVER

- BUILDING WRAP OVER EXTERIOR WALL PER MANUFACTURER'S RECOMMENDATIONS.
- FIBER CEMENT LAP SIDING WITH 10" REVEAL OVER BUILDING WRAP OVER EXTERIOR WALL PER MANUFACTURER'S RECOMMENDATIONS.
- ARTISAN FIBER CEMENT LAP SIDING WITH 10" REVEAL OVER EXTERIOR WALL PER MANUFACTURE'S SPECIFICATIONS.
- BRICK VENEER WITH 1" AIR SPACE ON BUILDING WRAP ON SHEATHING ON 2X WOOD STUD WALL
- STOREFRONT GLAZING SYSTEM. SEE FLOOR PLANS AND SCHEDULES
- 7 WHITE VINYL WINDOW. SEE FLOOR PLANS AND DOOR SCHEDULE
- GARAGE DOOR. SEE FLOOR PLANS AND DOOR
- MECHANICAL VENT. PAINTED TO MATCH ADJACENT WALL COLOR 17 BOARD AND BATTEN FIBER CEMENT
  - 18 METAL GATE. REFER TO PLANS AND DOOR SCHEDULE

BUILDING WRAP OVER EXTERIOR WALL PER

MANUFACTURER'S SPECIFICATIONS.

ARCHITECTURAL GRADE DOWNSPOUT AND GUTTER SYSTEM. COLOR TO MATCH ROOF.

12 CONDUCTOR HEAD WITH ARCHITECTURAL GRADE DOWNSPOUT.

BALCONY COLUMNS - FIBER CEMENT PANELS WITH CASING AT INTERSECTIONS, SEE DETAIL

10 ALUMINUM AWNING

13 4" X 8" OVERFLOW SCUPPER.

2/A7.42 (TYPICAL).

### 9 %" TRIM ON FIBER CEMENT PANEL SIDING OVER 19 DECORATIVE METAL. GRILL

- FIBER CEMENT PANEL OVER BUILDING WRAP OVER EXTERIOR WALL PER MANUFACTURER'S **SPECIFICATIONS**
- 21 LIGHT FIXTURE REFER TO ELECTRICAL DRAWINGS FOR MODEL & MANUFACTURER
- 22 42" HIGH ALUMINUM GUARD RAIL SYSTEM
- 23 EXTERIOR DOOR SYSTEM. SEE PLANS AND DOOR SCHEDULE. 24 OPEN BEYOND
- 25 STANDING METAL SEAM ROOF
- WINDOW TRIM AT SIDING TO HAVE 6" HEAD AND STOOL, 6" JAMBS AND \( \frac{1}{2} \)" SILL.

### TYPICAL EXTERIOR CLADDING - FIBER REINFORCED

FOR APPROVAL.

CEMENTITIOUS SIDING ON EXTERIOR SHEATHING WITH INTEGRATED WEATHER BARRIER. TAPE ALL CORNERS IN STRICT ACCORDANCE WITH MANUFACTURER'S RECOMMENDATIONS. SEE SHEET A7.81 FOR MORE INFORMATION.

TYPICAL ELEVATION NOTES

- ALL EXTERIOR DOOR TRIM TO BE FIBER REINFORCED CEMENTITOUS BOARD. REFER TO ELEVATIONS AND DETAILS FOR SIZES. ALL EXTERIOR WINDOW TRIM
- TO BE FOAM LTD SYSTEM. ALL PENETRATIONS MUST BE PROPERLY FLASHED
- AND/OR SEALED. ATTACHMENTS THROUGH EXTERIOR SKIN SHALL BE SET IN BED OF SEALANT.
- ALL BUILDING MOUNTED EQUIPMENT, PANELS, ETC. SHALL BE MOUNTED AFTER EXT. FINISH IS APPLIED AND PAINTED. IF SEQUENCING OF CONSTRUCTION REQUIRES MOUNTING PRIOR TO THIS, 11. ALL ATTACHMENT AND PENETRATION THRU THE CONTRACTOR SHALL SUBMIT METHOD OF

### MOUNTING AND WATERPROOFING TO ARCHITECT ALL EXTERIOR RAILS TO BE STEEL.

- 6. ALL FINISH GRADE SHALL BE MINIMUM 8" BELOW FINISH FLOOR AND SLOPE AWAY FROM BUILDING AT MIN 2% RATE.
- PROVIDE SILICONE SEALANT AT ALL INSIDE SIDING CORNERS. REFER TO DETAILS 10 & 11 ON SHEET
- A7.31 FOR CORNER DETAILS. PROVIDE SILICONE SEALANT W/ BOND BREAKER (TO PREVENT 3-SIDED ADHESION) AT TOP OF HORZ. BUILDING BANDS.
- PROVIDE SEALANT JOINTS AT INTERFACE BETWEEN DISSIMILAR SUBSTRATES, SUCH AS BREEZEWAY CEILINGS, BREEZEWAY EXTERIOR EDGES, EXTERIOR

1/A7.42 FOR DETAIL LOCATIONS.

WALL TO SOFFIT AND CEILING CONDITIONS ETC. 10. PROVIDE POSITIVE SLOPE 1:2 AT TOP OF HORIZONTAL PROJECTIONS, TYPICAL.

EXTERIOR CLADDING SYSTEM MUST BE SEALED
AGAINST POTENTIAL WATER INTRUSION. REFER TO 14/A7.51 and 15/A7.51

DOWNSPOUTS, TYP.

# BUILDING I - KEY PLAN

INCHES AND SHALL HAVE THE ENDS SEALED WITH CAULKING. COVERED WITH A H-SECTION JOINT COVER OR LOCATED OVER A STRIP OF FLASHING.


13. LAP SIDING SHALL BE LAPPED A MINIMUM OF 1 4"

14. REFER TO SHEET A7.03 FOR BUILDING WRAP INSTALLATION PRACTICES AT DOORS AND WINDOWS.

12. EXTERIOR WALLS TO BE COATED WITH PAINT

COATING PRIOR TO INSTALLATION OF THE

- 15. PROVIDE SUFFICIENT BLOCKING AT ALL CANOPY, AWNINGS AND BRACKET ATTACHMENTS. CONFIRM WITH SHOP DRAWINGS OF ELEMENTS.
- 16. CONTRACTOR TO COORDINATE MATERIAL AND PRODUCT CONFLICTS PRIOR TO INSTALLATION. INDICATES GUTTER AND DOWNSPOUT LOCATION. SEE DETAIL 7/A7.51, 8/A7.51,

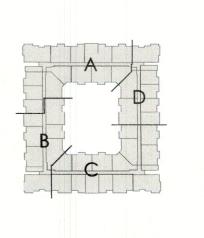

BUILDING TYPE FRONT AND RIGHT **ELEVATIONS** 

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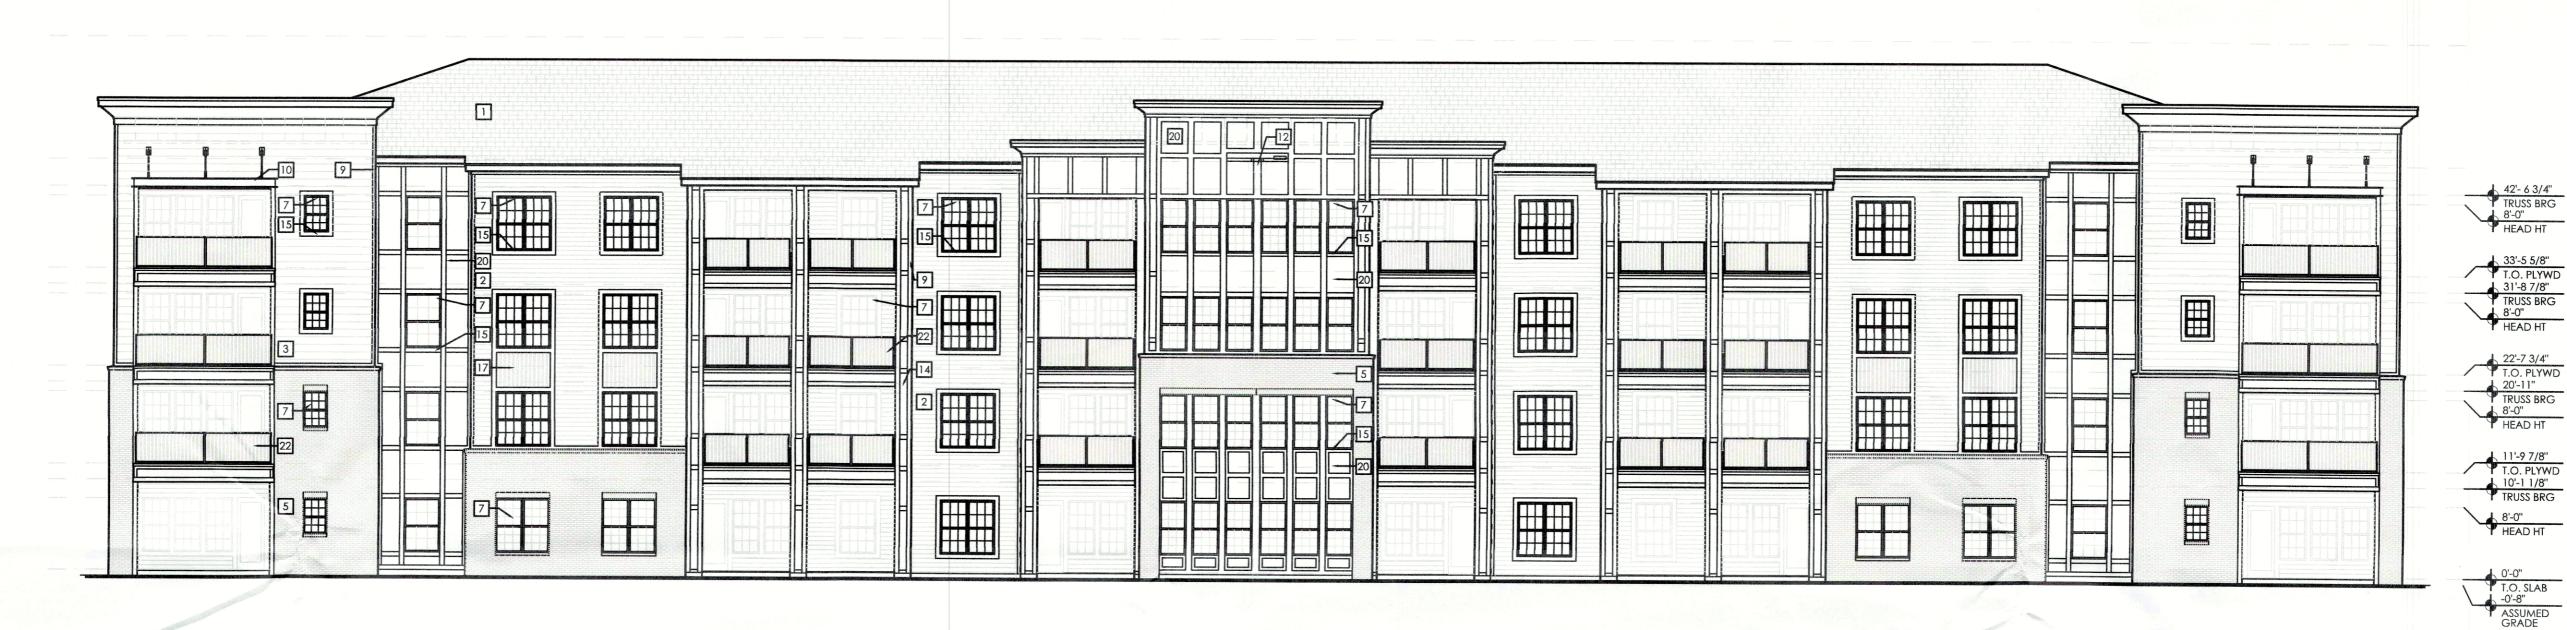
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LOUISVILLE APARTMENTS LOUISVILLE, KENTUCKY

date: 09-16-19 job no: 4204.19 drawn by: CBA reviewed by: CBA file: 4204A211 issue history:

# BUILDING TYPE I - LEFT SIDE ELEVATION

SCALE: 3/32'-1'-0'



BUILDING TYPE I - REAR SIDE ELEVATION

SCALE: 3/32"=1"-0"

HECEIVED PLANNING & DESIGN SERVICES

### **ELEVATION KEYED NOTES**

- ARCHITECTURAL GRADE ASPHALT SHINGLES ON #30 FELT OVER ROOF SHEATHING ON PRE-ENGINEERED WOOD TRUSSES ANCHORED @
- FIBER CEMENT LAP SIDING WITH 6" REVEAL OVER
- BUILDING WRAP OVER EXTERIOR WALL PER MANUFACTURER'S RECOMMENDATIONS.
- 3 FIBER CEMENT LAP SIDING WITH 10" REVEAL OVER BUILDING WRAP OVER EXTERIOR WALL PER MANUFACTURER'S RECOMMENDATIONS.
- 4 ARTISAN FIBER CEMENT LAP SIDING WITH 10" REVEAL OVER EXTERIOR WALL PER MANUFACTURE'S SPECIFICATIONS. BRICK VENEER WITH 1" AIR SPACE ON BUILDING
- WRAP ON SHEATHING ON 2X WOOD STUD WALL 6 STOREFRONT GLAZING SYSTEM, SEE FLOOR
- PLANS AND SCHEDULES WHITE VINYL WINDOW. SEE FLOOR PLANS AND DOOR SCHEDULE
- GARAGE DOOR. SEE FLOOR PLANS AND DOOR
- 9 X" TRIM ON FIBER CEMENT PANEL SIDING OVER 19 DECORATIVE METAL. GRILL BUILDING WRAP OVER EXTERIOR WALL PER MANUFACTURER'S SPECIFICATIONS.
- 10 ALUMINUM AWNING
- ARCHITECTURAL GRADE DOWNSPOUT AND GUTTER SYSTEM. COLOR TO MATCH ROOF.
- 12 CONDUCTOR HEAD WITH ARCHITECTURAL GRADE DOWNSPOUT. 13 4" X 8" OVERFLOW SCUPPER.
- BALCONY COLUMNS FIBER CEMENT PANELS WITH CASING AT INTERSECTIONS, SEE DETAIL 2/A7.42 (TYPICAL). STOOL, 6" JAMBS AND "SILL.
- 16 MECHANICAL VENT. PAINTED TO MATCH ADJACENT WALL COLOR 17 BOARD AND BATTEN FIBER CEMENT METAL GATE. REFER TO PLANS AND DOOR SCHEDULE
- 21 LIGHT FIXTURE REFER TO ELECTRICAL DRAWINGS FOR MODEL & MANUFACTURER 22 42" HIGH ALUMINUM GUARD RAIL SYSTEM

SPECIFICATIONS

23 EXTERIOR DOOR SYSTEM, SEE PLANS AND DOOR SCHEDULE.

20 FIBER CEMENT PANEL OVER BUILDING WRAP

OVER EXTERIOR WALL PER MANUFACTURER'S

- 24 OPEN BEYOND
- 25 STANDING METAL SEAM ROOF WINDOW TRIM AT SIDING TO HAVE 6" HEAD AND 26 DECORATIVE SHUTTERS
  - FOR APPROVAL.

### AT MIN 2% RATE.

TYPICAL EXTERIOR CLADDING - FIBER REINFORCED CEMENTITIOUS SIDING ON EXTERIOR SHEATHING WITH INTEGRATED WEATHER BARRIER. TAPE ALL CORNERS IN STRICT ACCORDANCE WITH MANUFACTURER'S RECOMMENDATIONS. SEE SHEET A7.81 FOR MORE INFORMATION.

TYPICAL ELEVATION NOTES

- ALL EXTERIOR DOOR TRIM TO BE FIBER REINFORCED CEMENTITOUS BOARD. REFER TO ELEVATIONS AND DETAILS FOR SIZES. ALL EXTERIOR WINDOW TRIM
- TO BE FOAM LTD SYSTEM. ALL PENETRATIONS MUST BE PROPERLY FLASHED AND/OR SEALED. ATTACHMENTS THROUGH
- EXTERIOR SKIN SHALL BE SET IN BED OF SEALANT. ALL BUILDING MOUNTED EQUIPMENT, PANELS, ETC. SHALL BE MOUNTED AFTER EXT. FINISH IS APPLIED AND PAINTED. IF SEQUENCING OF CONSTRUCTION
- REQUIRES MOUNTING PRIOR TO THIS, CONTRACTOR SHALL SUBMIT METHOD OF MOUNTING AND WATERPROOFING TO ARCHITECT ALL EXTERIOR RAILS TO BE STEEL.

### ALL FINISH GRADE SHALL BE MINIMUM 8" BELOW . EXTERIOR WALLS TO BE COATED WITH PAINT FINISH FLOOR AND SLOPE AWAY FROM BUILDING COATING PRIOR TO INSTALLATION OF THE DOWNSPOUTS, TYP.

13. LAP SIDING SHALL BE LAPPED A MINIMUM OF 1 4"

14. REFER TO SHEET A7.03 FOR BUILDING WRAP

INSTALLATION PRACTICES AT DOORS AND

15. PROVIDE SUFFICIENT BLOCKING AT ALL CANOPY,

16. CONTRACTOR TO COORDINATE MATERIAL AND

CONFIRM WITH SHOP DRAWINGS OF ELEMENTS.

AWNINGS AND BRACKET ATTACHMENTS.

INCHES AND SHALL HAVE THE ENDS SEALED WITH


COVER OR LOCATED OVER A STRIP OF FLASHING.

CAULKING. COVERED WITH A H-SECTION JOINT

- PROVIDE SILICONE SEALANT AT ALL INSIDE SIDING CORNERS. REFER TO DETAILS 10 & 11 ON SHEET A7.31 FOR CORNER DETAILS. PROVIDE SILICONE SEALANT W/ BOND BREAKER
- (TO PREVENT 3-SIDED ADHESION) AT TOP OF HORZ. BUILDING BANDS. PROVIDE SEALANT JOINTS AT INTERFACE BETWEEN
- DISSIMILAR SUBSTRATES, SUCH AS BREEZEWAY CEILINGS, BREEZEWAY EXTERIOR EDGES, EXTERIOR WALL TO SOFFIT AND CEILING CONDITIONS ETC. 10. PROVIDE POSITIVE SLOPE 1:2 AT TOP OF
- HORIZONTAL PROJECTIONS, TYPICAL. PRODUCT CONFLICTS PRIOR TO INSTALLATION. ALL ATTACHMENT AND PENETRATION THRU THE INDICATES GUTTER AND DOWNSPOUT LOCATION. SEE DETAIL 7/A7.51, 8/A7.51, EXTERIOR CLADDING SYSTEM MUST BE SEALED AGAINST POTENTIAL WATER INTRUSION. REFER TO 14/A7.51 and 15/A7.51 1/A7.42 FOR DETAIL LOCATIONS.

# BUILDING I - KEY PLAN



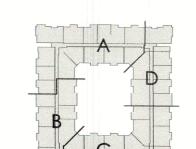

LOUISVILLE APARTMENTS LOUISVILLE, KENTUCKY

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BUILDING TYPE I

REAR AND LEFT

**ELEVATIONS** 


date: 09-16-19

job no: **4204.19** 

drawn by: CBA reviewed by: CBA file: 4204A212 issue history:



# BUILDING TYPE I - COURTYARD LEFT FITNESS ELEVATION

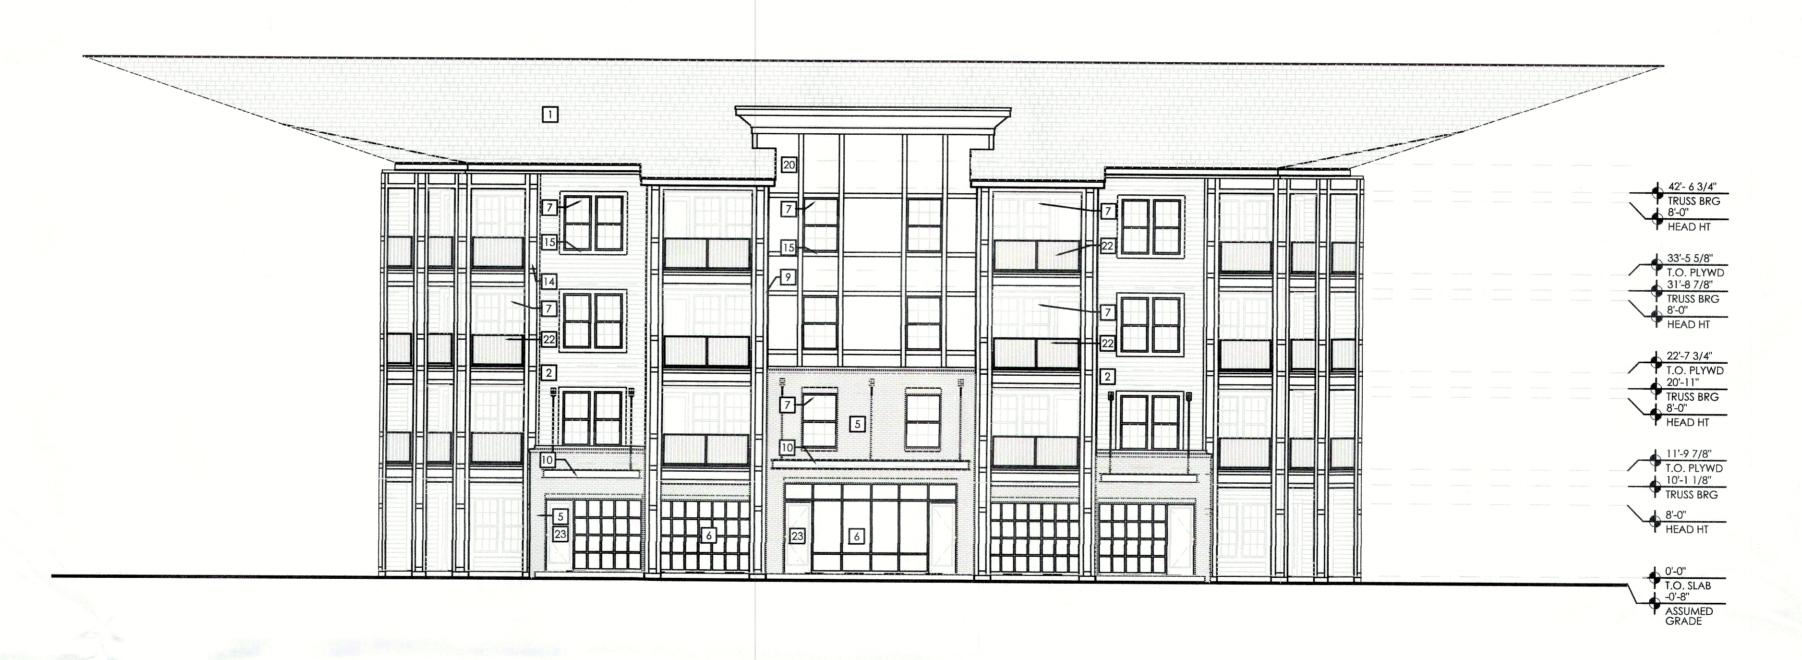

BUILDING TYPE I - COURTYARD REAR CLUB ELEVATION

SPECIFICATIONS

25 STANDING METAL SEAM ROOF

24 OPEN BEYOND

22 42" HIGH ALUMINUM GUARD RAIL SYSTEM

SCALE: 3/32"=1'-0"

LOUISVILLE APARTMENTS LOUISVILLE, KENTUCKY



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BUILDING TYPE I

POOL COURTYARD

**ELEVATIONS** 

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BUILDING I - KEY PLAN

date: 09-16-19 job no: **4204.19** drawn by: CBA reviewed by: CBA file: 4204A213

issue history:

COATING PRIOR TO INSTALLATION OF THE

ELEVATION KEYED NOTES

ARCHITECTURAL GRADE ASPHALT SHINGLES ON #30 FELT OVER ROOF SHEATHING ON PRE-ENGINEERED WOOD TRUSSES ANCHORED @

- FIBER CEMENT LAP SIDING WITH 6" REVEAL OVER BUILDING WRAP OVER EXTERIOR WALL PER MANUFACTURER'S RECOMMENDATIONS.
- FIBER CEMENT LAP SIDING WITH 10" REVEAL OVER BUILDING WRAP OVER EXTERIOR WALL PER MANUFACTURER'S RECOMMENDATIONS. 4 ARTISAN FIBER CEMENT LAP SIDING WITH 10"
- REVEAL OVER EXTERIOR WALL PER MANUFACTURE'S SPECIFICATIONS. BRICK VENEER WITH 1" AIR SPACE ON BUILDING
- WRAP ON SHEATHING ON 2X WOOD STUD WALL STOREFRONT GLAZING SYSTEM. SEE FLOOR PLANS AND SCHEDULES
- WHITE VINYL WINDOW. SEE FLOOR PLANS AND DOOR SCHEDULE B GARAGE DOOR. SEE FLOOR PLANS AND DOOR SCHEDULE
- 9 ¾" TRIM ON FIBER CEMENT PANEL SIDING OVER BUILDING WRAP OVER EXTERIOR WALL PER 19 DECORATIVE METAL. GRILL MANUFACTURER'S SPECIFICATIONS.
- 10 ALUMINUM AWNING ARCHITECTURAL GRADE DOWNSPOUT AND GUTTER SYSTEM. COLOR TO MATCH ROOF.
- 12 CONDUCTOR HEAD WITH ARCHITECTURAL GRADE DOWNSPOUT. 13 4" X 8" OVERFLOW SCUPPER.
- BALCONY COLUMNS FIBER CEMENT PANELS WITH CASING AT INTERSECTIONS, SEE DETAIL 2/A7.42 (TYPICAL). WINDOW TRIM AT SIDING TO HAVE 6" HEAD AND 26 DECORATIVE SHUTTERS
- MECHANICAL VENT. PAINTED TO MATCH ADJACENT WALL COLOR 17 BOARD AND BATTEN FIBER CEMENT

STOOL, 6" JAMBS AND 3/4" SILL.

- 18 METAL GATE. REFER TO PLANS AND DOOR SCHEDULE
- FIBER CEMENT PANEL OVER BUILDING WRAP OVER EXTERIOR WALL PER MANUFACTURER'S
- TYPICAL EXTERIOR CLADDING FIBER REINFORCED
  CEMENTITIOUS SIDING ON EXTERIOR SHEATHING

  6. ALL FINISH GRADE SHALL BE MINIMUM 8" BELOW FINISH FLOOR AND SLOPE AWAY FROM BUILDING WITH INTEGRATED WEATHER BARRIER. TAPE ALL CORNERS IN STRICT ACCORDANCE WITH MANUFACTURER'S RECOMMENDATIONS. SEE 21 LIGHT FIXTURE - REFER TO ELECTRICAL DRAWINGS FOR MODEL & MANUFACTURER SHEET A7.81 FOR MORE INFORMATION.

TYPICAL ELEVATION NOTES

- ALL EXTERIOR DOOR TRIM TO BE FIBER REINFORCED EMENTITOUS BOARD, REFER TO ELEVATIONS AND DETAILS FOR SIZES. ALL EXTERIOR WINDOW TRIM 23 EXTERIOR DOOR SYSTEM. SEE PLANS AND DOOR SCHEDULE. TO BE FOAM LTD SYSTEM.
  - ALL PENETRATIONS MUST BE PROPERLY FLASHED AND/OR SEALED. ATTACHMENTS THROUGH EXTERIOR SKIN SHALL BE SET IN BED OF SEALANT.
  - ALL BUILDING MOUNTED EQUIPMENT, PANELS, ETC. SHALL BE MOUNTED AFTER EXT. FINISH IS APPLIED
  - AND PAINTED, IF SEQUENCING OF CONSTRUCTION REQUIRES MOUNTING PRIOR TO THIS, CONTRACTOR SHALL SUBMIT METHOD OF MOUNTING AND WATERPROOFING TO ARCHITECT FOR APPROVAL. ALL EXTERIOR RAILS TO BE STEEL.
- HORZ. BUILDING BANDS. PROVIDE SEALANT JOINTS AT INTERFACE BETWEEN DISSIMILAR SUBSTRATES, SUCH AS BREEZEWAY CEILINGS, BREEZEWAY EXTERIOR EDGES, EXTERIOR WALL TO SOFFIT AND CEILING CONDITIONS ETC. 10. PROVIDE POSITIVE SLOPE 1:2 AT TOP OF

1/A7.42 FOR DETAIL LOCATIONS.

A7.31 FOR CORNER DETAILS.

HORIZONTAL PROJECTIONS, TYPICAL. ALL ATTACHMENT AND PENETRATION THRU THE EXTERIOR CLADDING SYSTEM MUST BE SEALED AGAINST POTENTIAL WATER INTRUSION. REFER TO

PROVIDE SILICONE SEALANT AT ALL INSIDE SIDING

CORNERS. REFER TO DETAILS 10 & 11 ON SHEET

PROVIDE SILICONE SEALANT W/ BOND BREAKER (TO PREVENT 3-SIDED ADHESION) AT TOP OF

- 13. LAP SIDING SHALL BE LAPPED A MINIMUM OF 1 4" INCHES AND SHALL HAVE THE ENDS SEALED WITH CAULKING. COVERED WITH A H-SECTION JOINT COVER OR LOCATED OVER A STRIP OF FLASHING.
- 14. REFER TO SHEET A7.03 FOR BUILDING WRAP

DOWNSPOUTS, TYP.

- INSTALLATION PRACTICES AT DOORS AND WINDOWS. 15. PROVIDE SUFFICIENT BLOCKING AT ALL CANOPY, AWNINGS AND BRACKET ATTACHMENTS.
- CONFIRM WITH SHOP DRAWINGS OF ELEMENTS. 16. CONTRACTOR TO COORDINATE MATERIAL AND

PRODUCT CONFLICTS PRIOR TO INSTALLATION. INDICATES GUTTER AND DOWNSPOUT LOCATION. SEE DETAIL 7/A7.51, 8/A7.51, 14/A7.51 and 15/A7.51

# BUILDING TYPE I - COURTYARD RIGHT ELEVATION

SCALE: 3/32"=1'-0"



# BUILDING TYPE I - COURTYARD REAR ELEVATION

SCALE: 3/32'-1'-0'

HECEIVED SEP 13 2019 PLANNING & **DESIGN SERVICES** 

BUILDING I - KEY PLAN

**ELEVATION KEYED NOTES** 

ARCHITECTURAL GRADE ASPHALT SHINGLES ON #30 FELT OVER ROOF SHEATHING ON PRE-ENGINEERED WOOD TRUSSES ANCHORED @

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STOREFRONT GLAZING SYSTEM. SEE FLOOR PLANS AND SCHEDULES

7 WHITE VINYL WINDOW. SEE FLOOR PLANS AND DOOR SCHEDULE GARAGE DOOR. SEE FLOOR PLANS AND DOOR SCHEDULE

WINDOW TRIM AT SIDING TO HAVE 6" HEAD AND 26 DECORATIVE SHUTTERS STOOL, 6" JAMBS AND 3" SILL. MECHANICAL VENT. PAINTED TO MATCH ADJACENT WALL COLOR 17 BOARD AND BATTEN FIBER CEMENT

MANUFACTURER'S SPECIFICATIONS.

ARCHITECTURAL GRADE DOWNSPOUT AND

GUTTER SYSTEM. COLOR TO MATCH ROOF.

BALCONY COLUMNS - FIBER CEMENT PANELS WITH CASING AT INTERSECTIONS, SEE DETAIL

CONDUCTOR HEAD WITH ARCHITECTURAL GRADE DOWNSPOUT.

10 ALUMINUM AWNING

13 4" X 8" OVERFLOW SCUPPER.

2/A7.42 (TYPICAL).

18 METAL GATE. REFER TO PLANS AND DOOR SCHEDULE

9 ¾" TRIM ON FIBER CEMENT PANEL SIDING OVER BUILDING WRAP OVER EXTERIOR WALL PER 19 DECORATIVE METAL. GRILL FIBER CEMENT PANEL OVER BUILDING WRAP OVER EXTERIOR WALL PER MANUFACTURER'S

24 OPEN BEYOND

25 STANDING METAL SEAM ROOF

CEMENTITIOUS SIDING ON EXTERIOR SHEATHING WITH INTEGRATED WEATHER BARRIER. TAPE ALL CORNERS IN STRICT ACCORDANCE WITH **SPECIFICATIONS** MANUFACTURER'S RECOMMENDATIONS. SEE 21 LIGHT FIXTURE - REFER TO ELECTRICAL DRAWING FOR MODEL & MANUFACTURER SHEET A7.81 FOR MORE INFORMATION.

ALL EXTERIOR DOOR TRIM TO BE FIBER REINFORCED 22 42" HIGH ALUMINUM GUARD RAIL SYSTEM CEMENTITOUS BOARD, REFER TO ELEVATIONS AND DETAILS FOR SIZES. ALL EXTERIOR WINDOW TRIM

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ALL BUILDING MOUNTED EQUIPMENT, PANELS, ETC. SHALL BE MOUNTED AFTER EXT. FINISH IS APPLIED AND PAINTED. IF SEQUENCING OF CONSTRUCTION REQUIRES MOUNTING PRIOR TO THIS, CONTRACTOR SHALL SUBMIT METHOD OF MOUNTING AND WATERPROOFING TO ARCHITECT

TYPICAL ELEVATION NOTES TYPICAL EXTERIOR CLADDING - FIBER REINFORCED

FOR APPROVAL. . ALL EXTERIOR RAILS TO BE STEEL. ALL FINISH GRADE SHALL BE MINIMUM 8" BELOW FINISH FLOOR AND SLOPE AWAY FROM BUILDING AT MIN 2% RATE.

PROVIDE SILICONE SEALANT AT ALL INSIDE SIDING CORNERS. REFER TO DETAILS 10 &11 ON SHEET A7.31 FOR CORNER DETAILS.

PROVIDE SILICONE SEALANT W/ BOND BREAKER (TO PREVENT 3-SIDED ADHESION) AT TOP OF HORZ. BUILDING BANDS.

PROVIDE SEALANT JOINTS AT INTERFACE BETWEEN DISSIMILAR SUBSTRATES, SUCH AS BREEZEWAY CEILINGS, BREEZEWAY EXTERIOR EDGES, EXTERIOR WALL TO SOFFIT AND CEILING CONDITIONS ETC. 10. PROVIDE POSITIVE SLOPE 1:2 AT TOP OF

HORIZONTAL PROJECTIONS, TYPICAL. . ALL ATTACHMENT AND PENETRATION THRU THE EXTERIOR CLADDING SYSTEM MUST BE SEALED AGAINST POTENTIAL WATER INTRUSION. REFER TO 1/A7.42 FOR DETAIL LOCATIONS.

COATING PRIOR TO INSTALLATION OF THE DOWNSPOUTS, TYP.

13. LAP SIDING SHALL BE LAPPED A MINIMUM OF 1 4" INCHES AND SHALL HAVE THE ENDS SEALED WITH CAULKING. COVERED WITH A H-SECTION JOINT COVER OR LOCATED OVER A STRIP OF FLASHING.

14. REFER TO SHEET A7.03 FOR BUILDING WRAP INSTALLATION PRACTICES AT DOORS AND

15. PROVIDE SUFFICIENT BLOCKING AT ALL CANOPY, AWNINGS AND BRACKET ATTACHMENTS. CONFIRM WITH SHOP DRAWINGS OF ELEMENTS. 16. CONTRACTOR TO COORDINATE MATERIAL AND PRODUCT CONFLICTS PRIOR TO INSTALLATION.

INDICATES GUTTER AND DOWNSPOUT LOCATION. SEE DETAIL 7/A7.51, 8/A7.51,

14/A7.51 and 15/A7.51

LOUISVILLE APARTMENTS LOUISVILLE, KENTUCKY



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BUILDING TYPE I

POOL COURTYARD

**ELEVATIONS** 

date: 09-16-19 job no: **4204.19** drawn by: CBA reviewed by: CBA file: 4204A214 issue history:

19-CAT3-0017

# BUILDING TYPE II - SIDE ELEVATION

SCALE: 3/32'=1'-0'



BUILDING TYPE II - FRONT ELEVATION

SCALE: 3/32"=1"-0"

HECEIVED SEP 13 2019

BUILDING II - KEY PLAN

PLANNING & **DESIGN SERVICES** 

### **ELEVATION KEYED NOTES**

- ARCHITECTURAL GRADE ASPHALT SHINGLES ON #30 FELT OVER ROOF SHEATHING ON PRE-ENGINEERED WOOD TRUSSES ANCHORED @
- 7 FIBER CEMENT LAP SIDING WITH 6" REVEAL OVER BUILDING WRAP OVER EXTERIOR WALL PER
- MANUFACTURER'S RECOMMENDATIONS. FIBER CEMENT LAP SIDING WITH 10" REVEAL OVER BUILDING WRAP OVER EXTERIOR WALL PER
- MANUFACTURER'S RECOMMENDATIONS. 4 ARTISAN FIBER CEMENT LAP SIDING WITH 10" REVEAL OVER EXTERIOR WALL PER MANUFACTURE'S SPECIFICATIONS.
- 5 BRICK VENEER WITH 1" AIR SPACE ON BUILDING
- WRAP ON SHEATHING ON 2X WOOD STUD WALL STOREFRONT GLAZING SYSTEM, SEE FLOOR PLANS AND SCHEDULES
- 7 WHITE VINYL WINDOW. SEE FLOOR PLANS AND DOOR SCHEDULE GARAGE DOOR. SEE FLOOR PLANS AND DOOR SCHEDULE
- MECHANICAL VENT. PAINTED TO MATCH ADJACENT WALL COLOR
  - 17 BOARD AND BATTEN FIBER CEMENT 18 METAL GATE. REFER TO PLANS AND DOOR SCHEDULE

STOOL, 6" JAMBS AND 3/4" SILL.

MANUFACTURER'S SPECIFICATIONS.

ARCHITECTURAL GRADE DOWNSPOUT AND GUTTER SYSTEM. COLOR TO MATCH ROOF.

12 CONDUCTOR HEAD WITH ARCHITECTURAL GRADE DOWNSPOUT.

BALCONY COLUMNS - FIBER CEMENT PANELS WITH CASING AT INTERSECTIONS, SEE DETAIL

10 ALUMINUM AWNING

13 4" X 8" OVERFLOW SCUPPER.

2/A7.42 (TYPICAL).

# 9 %" TRIM ON FIBER CEMENT PANEL SIDING OVER BUILDING WRAP OVER EXTERIOR WALL PER

- FIBER CEMENT PANEL OVER BUILDING WRAP OVER EXTERIOR WALL PER MANUFACTURER'S **SPECIFICATIONS** 21 LIGHT FIXTURE - REFER TO ELECTRICAL DRAWINGS FOR MODEL & MANUFACTURER SHEET A7.81 FOR MORE INFORMATION.
- 22 42" HIGH ALUMINUM GUARD RAIL SYSTEM
- EXTERIOR DOOR SYSTEM. SEE PLANS AND DOOR SCHEDULE.
- 24 OPEN BEYOND 25 STANDING METAL SEAM ROOF

# 15 WINDOW TRIM AT SIDING TO HAVE 6" HEAD AND 26 DECORATIVE SHUTTERS

## TO BE FOAM LTD SYSTEM.

DISSIMILAR SUBSTRATES, SUCH AS BREEZEWAY AND/OR SEALED. ATTACHMENTS THROUGH CEILINGS, BREEZEWAY EXTERIOR EDGES, EXTERIOR EXTERIOR SKIN SHALL BE SET IN BED OF SEALANT. WALL TO SOFFIT AND CEILING CONDITIONS ETC. ALL BUILDING MOUNTED EQUIPMENT, PANELS, ETC. SHALL BE MOUNTED AFTER EXT. FINISH IS APPLIED 10. PROVIDE POSITIVE SLOPE 1:2 AT TOP OF AND PAINTED. IF SEQUENCING OF CONSTRUCTION

ALL EXTERIOR RAILS TO BE STEEL.

### TYPICAL ELEVATION NOTES

- TYPICAL EXTERIOR CLADDING FIBER REINFORCED 6. ALL FINISH GRADE SHALL BE MINIMUM 8" BELOW CEMENTITIOUS SIDING ON EXTERIOR SHEATHING WITH INTEGRATED WEATHER BARRIER. TAPE ALL CORNERS IN STRICT ACCORDANCE WITH MANUFACTURER'S RECOMMENDATIONS. SEE
- ALL EXTERIOR DOOR TRIM TO BE FIBER REINFORCED CEMENTITOUS BOARD, REFER TO ELEVATIONS AND DETAILS FOR SIZES. ALL EXTERIOR WINDOW TRIM

# ALL PENETRATIONS MUST BE PROPERLY FLASHED

REQUIRES MOUNTING PRIOR TO THIS, CONTRACTOR SHALL SUBMIT METHOD OF MOUNTING AND WATERPROOFING TO ARCHITECT FOR APPROVAL.

### HORIZONTAL PROJECTIONS, TYPICAL. 11. ALL ATTACHMENT AND PENETRATION THRU THE EXTERIOR CLADDING SYSTEM MUST BE SEALED AGAINST POTENTIAL WATER INTRUSION. REFER TO

1/A7.42 FOR DETAIL LOCATIONS.

AT MIN 2% RATE.

### 12. EXTERIOR WALLS TO BE COATED WITH PAINT FINISH FLOOR AND SLOPE AWAY FROM BUILDING COATING PRIOR TO INSTALLATION OF THE

DOWNSPOUTS, TYP.

- . PROVIDE SILICONE SEALANT AT ALL INSIDE SIDING 13. LAP SIDING SHALL BE LAPPED A MINIMUM OF 1 1/4" CORNERS. REFER TO DETAILS 10 &11 ON SHEET INCHES AND SHALL HAVE THE ENDS SEALED WITH A7.31 FOR CORNER DETAILS. CAULKING. COVERED WITH A H-SECTION JOINT
- COVER OR LOCATED OVER A STRIP OF FLASHING. PROVIDE SILICONE SEALANT W/ BOND BREAKER (TO PREVENT 3-SIDED ADHESION) AT TOP OF 14. REFER TO SHEET A7.03 FOR BUILDING WRAP HORZ. BUILDING BANDS. INSTALLATION PRACTICES AT DOORS AND
- WINDOWS. PROVIDE SEALANT JOINTS AT INTERFACE BETWEEN 15. PROVIDE SUFFICIENT BLOCKING AT ALL CANOPY,

14/A7.51 and 15/A7.51

AWNINGS AND BRACKET ATTACHMENTS. CONFIRM WITH SHOP DRAWINGS OF ELEMENTS. 16. CONTRACTOR TO COORDINATE MATERIAL AND PRODUCT CONFLICTS PRIOR TO INSTALLATION.

INDICATES GUTTER AND DOWNSPOUT LOCATION. SEE DETAIL 7/A7.51, 8/A7.51,

job no: 4204.19 drawn by: CBA reviewed by: CBA file: 4204A221

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**BUILDING TYPE II** 

FRONT AND SIDE

**ELEVATIONS** 

date: 09-16-19

issue history:



BUILDING TYPE II - REAR ELEVATION

SCALE: 3/32"=1'-0"

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BUILDING TYPE II

REAR

**ELEVATION** 

date: 09-16-19 job no: **4204.19** drawn by: CBA reviewed by: CBA file: 4204A222

issue history:

ELEVATION KEYED NOTES

ARCHITECTURAL GRADE ASPHALT SHINGLES ON #30 FELT OVER ROOF SHEATHING ON PRE-ENGINEERED WOOD TRUSSES ANCHORED @

2 FIBER CEMENT LAP SIDING WITH 6" REVEAL OVER

BUILDING WRAP OVER EXTERIOR WALL PER MANUFACTURER'S RECOMMENDATIONS. FIBER CEMENT LAP SIDING WITH 10" REVEAL OVER

BUILDING WRAP OVER EXTERIOR WALL PER MANUFACTURER'S RECOMMENDATIONS. 4 ARTISAN FIBER CEMENT LAP SIDING WITH 10" REVEAL OVER EXTERIOR WALL PER MANUFACTURE'S SPECIFICATIONS.

5 BRICK VENEER WITH 1" AIR SPACE ON BUILDING WRAP ON SHEATHING ON 2X WOOD STUD WALL

STOREFRONT GLAZING SYSTEM. SEE FLOOR PLANS AND SCHEDULES

7 WHITE VINYL WINDOW. SEE FLOOR PLANS AND DOOR SCHEDULE GARAGE DOOR. SEE FLOOR PLANS AND DOOR SCHEDULE

MANUFACTURER'S SPECIFICATIONS. 10 ALUMINUM AWNING

ARCHITECTURAL GRADE DOWNSPOUT AND GUTTER SYSTEM. COLOR TO MATCH ROOF.

CONDUCTOR HEAD WITH ARCHITECTURAL GRADE DOWNSPOUT.

13 4" X 8" OVERFLOW SCUPPER. BALCONY COLUMNS - FIBER CEMENT PANELS WITH CASING AT INTERSECTIONS, SEE DETAIL 2/A7.42 (TYPICAL).

WINDOW TRIM AT SIDING TO HAVE 6" HEAD AND STOOL, 6" JAMBS AND "SILL. MECHANICAL VENT. PAINTED TO MATCH ADJACENT WALL COLOR

17 BOARD AND BATTEN FIBER CEMENT 18 METAL GATE. REFER TO PLANS AND DOOR SCHEDULE

FIBER CEMENT PANEL OVER BUILDING WRAP 20 FIBER CEMENI PANEL OVER BUILDING TO THE OVER EXTERIOR WALL PER MANUFACTURER'S

25 STANDING METAL SEAM ROOF

**SPECIFICATIONS** 21 LIGHT FIXTURE - REFER TO ELECTRICAL DRAWING FOR MODEL & MANUFACTURER 22 42" HIGH ALUMINUM GUARD RAIL SYSTEM

23 EXTERIOR DOOR SYSTEM. SEE PLANS AND DOOR SCHEDULE. 24 OPEN BEYOND

ALL PENETRATIONS MUST BE PROPERLY FLASHED AND/OR SEALED. ATTACHMENTS THROUGH EXTERIOR SKIN SHALL BE SET IN BED OF SEALANT.

ALL EXTERIOR RAILS TO BE STEEL.

TO BE FOAM LTD SYSTEM.

ALL BUILDING MOUNTED EQUIPMENT, PANELS, ETC. SHALL BE MOUNTED AFTER EXT. FINISH IS APPLIED AND PAINTED. IF SEQUENCING OF CONSTRUCTION REQUIRES MOUNTING PRIOR TO THIS, CONTRACTOR SHALL SUBMIT METHOD OF MOUNTING AND WATERPROOFING TO ARCHITECT FOR APPROVAL.

TYPICAL ELEVATION NOTES

TYPICAL EXTERIOR CLADDING - FIBER REINFORCED

CEMENTITIOUS SIDING ON EXTERIOR SHEATHING

WITH INTEGRATED WEATHER BARRIER. TAPE ALL

CORNERS IN STRICT ACCORDANCE WITH

ALL FINISH GRADE SHALL BE MINIMUM 8" BELOW FINISH FLOOR AND SLOPE AWAY FROM BUILDING AT MIN 2% RATE. PROVIDE SILICONE SEALANT AT ALL INSIDE SIDING

MANUFACTURER'S RECOMMENDATIONS. SEE CORNERS. REFER TO DETAILS 10 &11 ON SHEET SHEET A7.81 FOR MORE INFORMATION. A7.31 FOR CORNER DETAILS. ALL EXTERIOR DOOR TRIM TO BE FIBER REINFORCED CEMENTITOUS BOARD. REFER TO ELEVATIONS AND PROVIDE SILICONE SEALANT W/ BOND BREAKER DETAILS FOR SIZES. ALL EXTERIOR WINDOW TRIM

(TO PREVENT 3-SIDED ADHESION) AT TOP OF HORZ. BUILDING BANDS.

PROVIDE SEALANT JOINTS AT INTERFACE BETWEEN DISSIMILAR SUBSTRATES, SUCH AS BREEZEWAY CEILINGS, BREEZEWAY EXTERIOR EDGES, EXTERIOR WALL TO SOFFIT AND CEILING CONDITIONS ETC. 10. PROVIDE POSITIVE SLOPE 1:2 AT TOP OF HORIZONTAL PROJECTIONS, TYPICAL.

. ALL ATTACHMENT AND PENETRATION THRU THE EXTERIOR CLADDING SYSTEM MUST BE SEALED AGAINST POTENTIAL WATER INTRUSION. REFER TO 1/A7.42 FOR DETAIL LOCATIONS.


COATING PRIOR TO INSTALLATION OF THE DOWNSPOUTS, TYP.

13. LAP SIDING SHALL BE LAPPED A MINIMUM OF 1 4" INCHES AND SHALL HAVE THE ENDS SEALED WITH CAULKING. COVERED WITH A H-SECTION JOINT

COVER OR LOCATED OVER A STRIP OF FLASHING. 14. REFER TO SHEET A7.03 FOR BUILDING WRAP INSTALLATION PRACTICES AT DOORS AND

15. PROVIDE SUFFICIENT BLOCKING AT ALL CANOPY, AWNINGS AND BRACKET ATTACHMENTS. CONFIRM WITH SHOP DRAWINGS OF ELEMENTS.

16. CONTRACTOR TO COORDINATE MATERIAL AND PRODUCT CONFLICTS PRIOR TO INSTALLATION. INDICATES GUTTER AND DOWNSPOUT LOCATION. SEE DETAIL 7/A7.51, 8/A7.51, 14/A7.51 and 15/A7.51

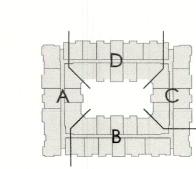

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BUILDING II - KEY PLAN



19'-9"
TRUSS BRG.
8'-0" AFF
WDW. HD.

10'-7 7/8" TOP OF PLWD.

9'-1 1/8"
TRUSS BRG.
8'-0" AFF
WDW. HD.

0'-0"
TOP OF SLAB

BUILDING TYPE FIVE - REAR ELEVATION

SCALE: 1/8'-1'-0'



BUILDING TYPE FIVE - RIGHT ELEVATION

SCALE: 1/8"=1'-0"



BUILDING TYPE FIVE - LEFT ELEVATION SCALE: 1/8'=1'-0'

19 DECORATIVE METAL. GRILL

**SPECIFICATIONS** 



BUILDING TYPE FIVE - FRONT ELEVATION

SCALE: 1/8'-1'-0'

HECEIVED SEP 13 2019

**BUILDING TYPE III** 

date: 09-16-19 job no: 4204.19

drawn by: AJF

file: 4204A231

issue history:

reviewed by: CBA

EXTERIOR ELEVATIONS

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PLANNING & **DESIGN SERVICES** 

### **ELEVATION KEYED NOTES**

- ARCHITECTURAL GRADE ASPHALT SHINGLES ON #30 FELT OVER ROOF SHEATHING ON PRE-ENGINEERED WOOD TRUSSES ANCHORED @ 7 FIBER CEMENT LAP SIDING WITH 6" REVEAL OVER
- BUILDING WRAP OVER EXTERIOR WALL PER MANUFACTURER'S RECOMMENDATIONS. FIBER CEMENT LAP SIDING WITH 10" REVEAL OVER BUILDING WRAP OVER EXTERIOR WALL PER
- MANUFACTURER'S RECOMMENDATIONS. 4 ARTISAN FIBER CEMENT LAP SIDING WITH 10" REVEAL OVER EXTERIOR WALL PER
- MANUFACTURE'S SPECIFICATIONS. 5 BRICK VENEER WITH 1" AIR SPACE ON BUILDING WRAP ON SHEATHING ON 2X WOOD STUD WALL
- STOREFRONT GLAZING SYSTEM. SEE FLOOR PLANS AND SCHEDULES
- WHITE VINYL WINDOW. SEE FLOOR PLANS AND DOOR SCHEDULE
- GARAGE DOOR. SEE FLOOR PLANS AND DOOR SCHEDULE

- 9 1/2" TRIM ON FIBER CEMENT PANEL SIDING OVER BUILDING WRAP OVER EXTERIOR WALL PER MANUFACTURER'S SPECIFICATIONS.
- 10 ALUMINUM AWNING
- ARCHITECTURAL GRADE DOWNSPOUT AND GUTTER SYSTEM. COLOR TO MATCH ROOF.
- CONDUCTOR HEAD WITH ARCHITECTURAL GRADE DOWNSPOUT.
- 13 4" X 8" OVERFLOW SCUPPER. BALCONY COLUMNS - FIBER CEMENT PANELS WITH CASING AT INTERSECTIONS, SEE DETAIL

2/A7.42 (TYPICAL).

- WINDOW TRIM AT SIDING TO HAVE 6" HEAD AND STOOL, 6" JAMBS AND 125 DECORATIVE SHUTTERS
- MECHANICAL VENT. PAINTED TO MATCH ADJACENT WALL COLOR
- 17 BOARD AND BATTEN FIBER CEMENT 18 METAL GATE. REFER TO PLANS AND DOOR SCHEDULE

### TYPICAL ELEVATION NOTES

- TYPICAL EXTERIOR CLADDING FIBER REINFORCED CEMENTITIOUS SIDING ON EXTERIOR SHEATHING FIBER CEMENT PANEL OVER BUILDING WRAP OVER EXTERIOR WALL PER MANUFACTURER'S WITH INTEGRATED WEATHER BARRIER. TAPE ALL CORNERS IN STRICT ACCORDANCE WITH MANUFACTURER'S RECOMMENDATIONS. SEE SHEET A7.81 FOR MORE INFORMATION.
- 21 LIGHT FIXTURE REFER TO ELECTRICAL DRAWINGS FOR MODEL & MANUFACTURER ALL EXTERIOR DOOR TRIM TO BE FIBER REINFORCED 22 42" HIGH ALUMINUM GUARD RAIL SYSTEM CEMENTITOUS BOARD. REFER TO ELEVATIONS AND DETAILS FOR SIZES. ALL EXTERIOR WINDOW TRIM
- EXTERIOR DOOR SYSTEM. SEE PLANS AND DOOR SCHEDULE. TO BE FOAM LTD SYSTEM. 24 OPEN BEYOND ALL PENETRATIONS MUST BE PROPERLY FLASHED
- 25 STANDING METAL SEAM ROOF EXTERIOR SKIN SHALL BE SET IN BED OF SEALANT.
  - ALL BUILDING MOUNTED EQUIPMENT, PANELS, ETC. SHALL BE MOUNTED AFTER EXT. FINISH IS APPLIED AND PAINTED. IF SEQUENCING OF CONSTRUCTION REQUIRES MOUNTING PRIOR TO THIS, CONTRACTOR SHALL SUBMIT METHOD OF MOUNTING AND WATERPROOFING TO ARCHITECT FOR APPROVAL.

AND/OR SEALED. ATTACHMENTS THROUGH

ALL EXTERIOR RAILS TO BE STEEL.

### ALL FINISH GRADE SHALL BE MINIMUM 8" BELOW FINISH FLOOR AND SLOPE AWAY FROM BUILDING

- AT MIN 2% RATE. PROVIDE SILICONE SEALANT AT ALL INSIDE SIDING CORNERS. REFER TO DETAILS 10 & 11 ON SHEET A7.31 FOR CORNER DETAILS.
- PROVIDE SILICONE SEALANT W/ BOND BREAKER (TO PREVENT 3-SIDED ADHESION) AT TOP OF HORZ. BUILDING BANDS.
- PROVIDE SEALANT JOINTS AT INTERFACE BETWEEN DISSIMILAR SUBSTRATES, SUCH AS BREEZEWAY CEILINGS, BREEZEWAY EXTERIOR EDGES, EXTERIOR


WALL TO SOFFIT AND CEILING CONDITIONS ETC.

- 10. PROVIDE POSITIVE SLOPE 1:2 AT TOP OF HORIZONTAL PROJECTIONS, TYPICAL.
- 11. ALL ATTACHMENT AND PENETRATION THRU THE EXTERIOR CLADDING SYSTEM MUST BE SEALED AGAINST POTENTIAL WATER INTRUSION. REFER TO 1/A7.42 FOR DETAIL LOCATIONS.

### 12. EXTERIOR WALLS TO BE COATED WITH PAINT COATING PRIOR TO INSTALLATION OF THE DOWNSPOUTS, TYP.


- LAP SIDING SHALL BE LAPPED A MINIMUM OF 1 1/4" INCHES AND SHALL HAVE THE ENDS SEALED WITH CAULKING. COVERED WITH A H-SECTION JOINT COVER OR LOCATED OVER A STRIP OF FLASHING.
- 14. REFER TO SHEET A7.03 FOR BUILDING WRAP INSTALLATION PRACTICES AT DOORS AND WINDOWS.
- PROVIDE SUFFICIENT BLOCKING AT ALL CANOPY, AWNINGS AND BRACKET ATTACHMENTS. CONFIRM WITH SHOP DRAWINGS OF ELEMENTS.
- 16. CONTRACTOR TO COORDINATE MATERIAL AND PRODUCT CONFLICTS PRIOR TO INSTALLATION.
- INDICATES GUTTER AND DOWNSPOUT LOCATION. SEE DETAIL 7/A7.51, 8/A7.51, 14/A7.51 and 15/A7.51


### BUILDING III - KEY PLAN

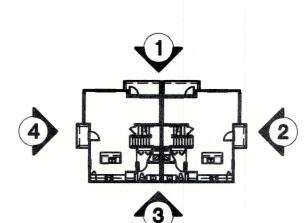

19-CAT3-0017



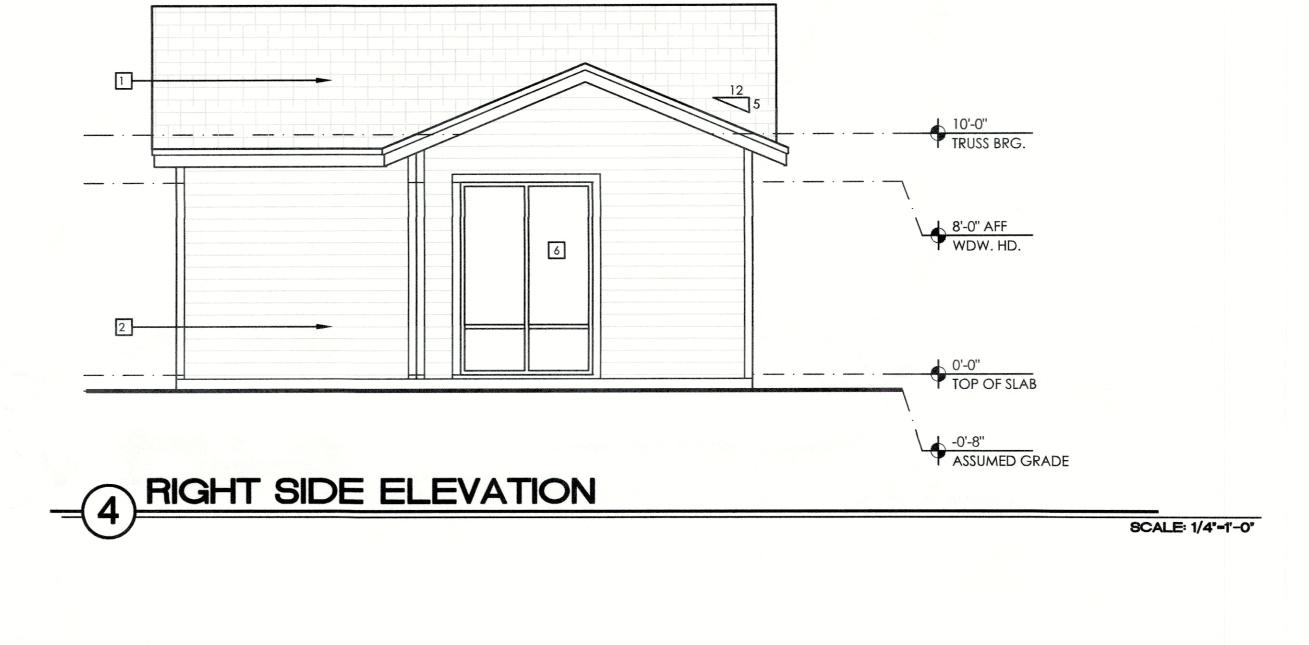

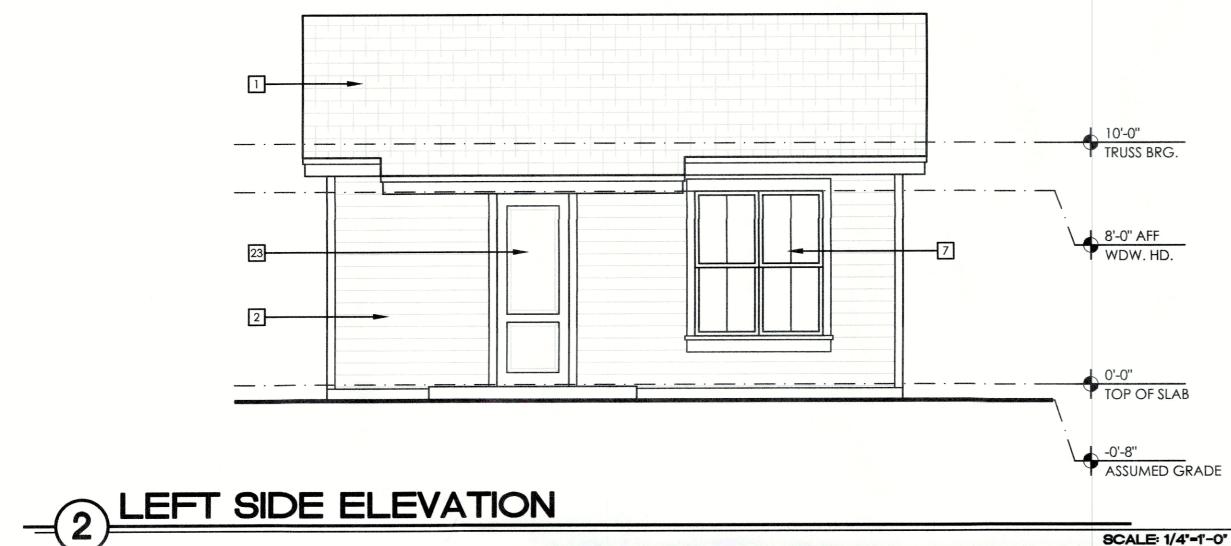

8'-0" AFF WDW. HD. ASSUMED GRADE FRONT ELEVATION SCALE: 1/4'=1'-0'

ALL FINISH GRADE SHALL BE MINIMUM 8" BELOW

PROVIDE SILICONE SEALANT W/ BOND BREAKER

PROVIDE SEALANT JOINTS AT INTERFACE BETWEEN

CEILINGS, BREEZEWAY EXTERIOR EDGES, EXTERIOR

WALL TO SOFFIT AND CEILING CONDITIONS ETC.

PROVIDE POSITIVE SLOPE 1:2 AT TOP OF

1/A7.42 FOR DETAIL LOCATIONS.

HORIZONTAL PROJECTIONS, TYPICAL.

11. ALL ATTACHMENT AND PENETRATION THRU THE

EXTERIOR CLADDING SYSTEM MUST BE SEALED

AGAINST POTENTIAL WATER INTRUSION. REFER TO

DISSIMILAR SUBSTRATES, SUCH AS BREEZEWAY

(TO PREVENT 3-SIDED ADHESION) AT TOP OF

AT MIN 2% RATE.

HORZ. BUILDING BANDS.

FINISH FLOOR AND SLOPE AWAY FROM BUILDING

**DESIGN SERVICES** 

## RECEIVED SEP 13 2019 PLANNING &

### **ELEVATION KEYED NOTES** ARCHITECTURAL GRADE ASPHALT SHINGLES ON #30 FELT OVER ROOF SHEATHING ON PRE-ENGINEERED WOOD TRUSSES ANCHORED @ EA. END.

- FIBER CEMENT LAP SIDING WITH 6" REVEAL OVER
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- WRAP ON SHEATHING ON 2X WOOD STUD WALL
- STOREFRONT GLAZING SYSTEM. SEE FLOOR PLANS AND SCHEDULES WHITE VINYL WINDOW. SEE FLOOR PLANS AND DOOR SCHEDULE
- GARAGE DOOR. SEE FLOOR PLANS AND DOOR SCHEDULE

- 9 1/4" TRIM ON FIBER CEMENT PANEL SIDING OVER BUILDING WRAP OVER EXTERIOR WALL PER MANUFACTURER'S SPECIFICATIONS.
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- WINDOW TRIM AT SIDING TO HAVE 6" HEAD AND 26 DECORATIVE SHUTTERS STOOL, 6" JAMBS AND ¾" SILL.

17 BOARD AND BATTEN FIBER CEMENT

- MECHANICAL VENT. PAINTED TO MATCH ADJACENT WALL COLOR
- METAL GATE. REFER TO PLANS AND DOOR SCHEDULE

### 19 DECORATIVE METAL. GRILL

- FIBER CEMENT PANEL OVER BUILDING WRAP OVER EXTERIOR WALL PER MANUFACTURER'S **SPECIFICATIONS**
- 21 LIGHT FIXTURE REFER TO ELECTRICAL DRAWINGS FOR MODEL & MANUFACTURER
- 22 42" HIGH ALUMINUM GUARD RAIL SYSTEM 23 EXTERIOR DOOR SYSTEM. SEE PLANS AND DOOR SCHEDULE.

SCALE: 1/4"=1'-0"

- 24 OPEN BEYOND 25 STANDING METAL SEAM ROOF

### TYPICAL ELEVATION NOTES

- TYPICAL EXTERIOR CLADDING FIBER REINFORCED CEMENTITIOUS SIDING ON EXTERIOR SHEATHING WITH INTEGRATED WEATHER BARRIER. TAPE ALL CORNERS IN STRICT ACCORDANCE WITH MANUFACTURER'S RECOMMENDATIONS. SEE
- ALL EXTERIOR DOOR TRIM TO BE FIBER REINFORCED CEMENTITOUS BOARD. REFER TO ELEVATIONS AND DETAILS FOR SIZES. ALL EXTERIOR WINDOW TRIM


SHEET A7.81 FOR MORE INFORMATION.

- TO BE FOAM LTD SYSTEM.
- ALL PENETRATIONS MUST BE PROPERLY FLASHED AND/OR SEALED. ATTACHMENTS THROUGH EXTERIOR SKIN SHALL BE SET IN BED OF SEALANT.
- ALL BUILDING MOUNTED EQUIPMENT, PANELS, ETC. SHALL BE MOUNTED AFTER EXT. FINISH IS APPLIED AND PAINTED. IF SEQUENCING OF CONSTRUCTION REQUIRES MOUNTING PRIOR TO THIS, CONTRACTOR SHALL SUBMIT METHOD OF MOUNTING AND WATERPROOFING TO ARCHITECT FOR APPROVAL.
- 5. ALL EXTERIOR RAILS TO BE STEEL.

- 12. EXTERIOR WALLS TO BE COATED WITH PAINT COATING PRIOR TO INSTALLATION OF THE DOWNSPOUTS, TYP.
- PROVIDE SILICONE SEALANT AT ALL INSIDE SIDING 13. LAP SIDING SHALL BE LAPPED A MINIMUM OF  $1\frac{1}{4}$ CORNERS. REFER TO DETAILS 10 &11 ON SHEET INCHES AND SHALL HAVE THE ENDS SEALED WITH A7.31 FOR CORNER DETAILS. CAULKING. COVERED WITH A H-SECTION JOINT
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- INDICATES GUTTER AND DOWNSPOUT LOCATION. SEE DETAIL 7/A7.51, 8/A7.51, 14/A7.51 and 15/A7.51



MAINTENANCE - KEY PLAN
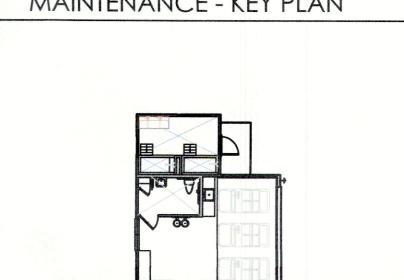
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MAINTENANCE

DOG WASH

BUILDING

**ELEVATIONS** 

date: 09-16-19 job no: **4204.19** 

drawn by: CR


file: 4204A241

issue history:

reviewed by: CBA

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1770

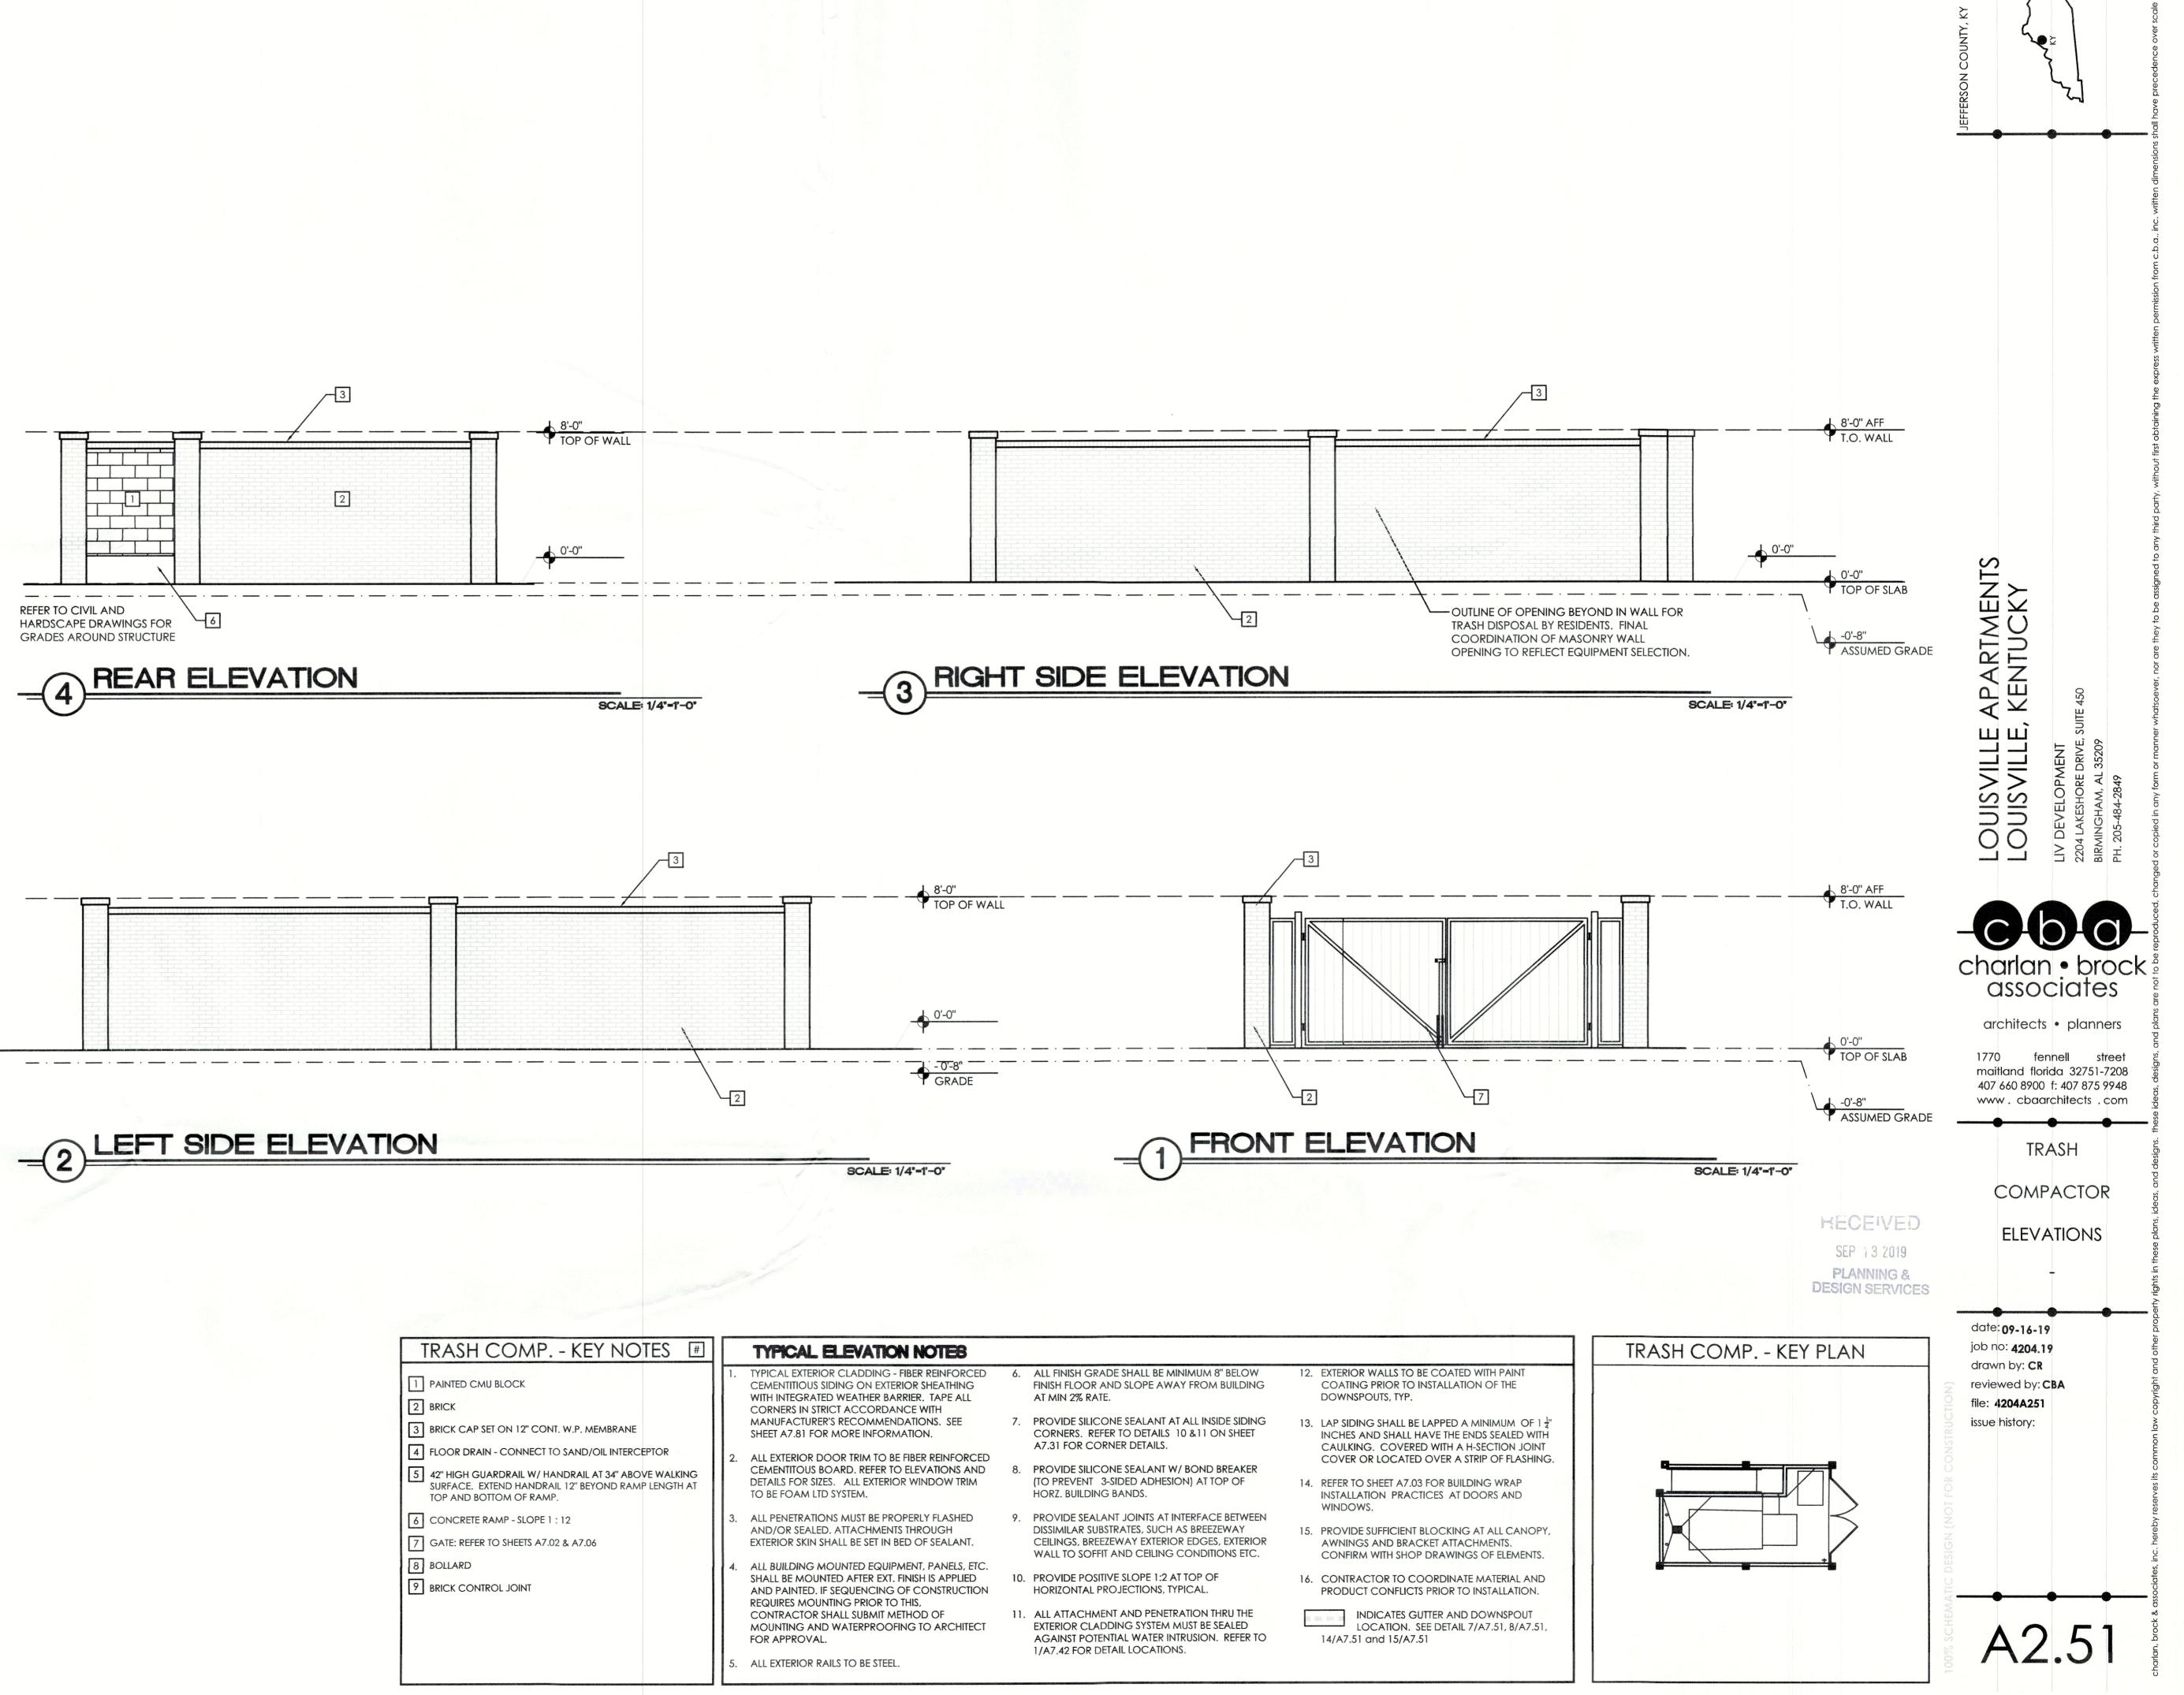

19-CAT3-001)